(Continued from Application Form III. Description of Proposed Work)

Project Goals:

The construction of the Scarborough Pond crossing is intended to:

- Eliminate golf cart related traffic on the stone arch bridge thus reestablishing pedestrian only traffic
- Realign golf cart paths to reduce wear and tear on the 16th and 17th golf holes and achieve a significant net reduction in the total length of cart paths in this vicinity.
- Eliminate delays caused by the circulation conflicts and bottlenecks that occurs at the stone arch bridge.
- Reduce safety hazards (players proceeding from the 17th tee to the 17th fairway now must reverse their direction and cross in front of the 16th green, cross the historic stone arch bridge, then cross the 16th golf fairway to access the 17th fairway and green. This circulation pattern puts players on both sides of the pond in the direct path of approaching golf shots from the 16th fairway.

Project Specifics:

The project involves the construction of a cart boardwalk at Scarborough Pond, several short legs of asphalt cart path, limited grading, removal of redundant cart path sections, and turf reestablishment. The precedent for cart paths is well established throughout the golf course.

The Scarborough Pond crossing is achieved by the construction of a mostly wooden boardwalk structure. The structure's alignment meanders and dips in elevation at the center. The boardwalk is 150' in length x 8' in total width, with a 6' clear usable width for carts and pedestrians. Specifications include:


- Wood beams, stringers, decking and curbing
- Rail system that includes wood posts (10-foot on center) with horizontal stainless-steel cables
- Helical steel piles and lateral supports
- Concrete abutments (both buried)

Design Aesthetic:

As custodian of the critically important landscapes that make up Franklin Park, the BPRD has sought to strike the proper aesthetic balance in the design of the Scarborough Crossing. The aesthetic qualities are described as follows:

- The low-profile cart boardwalk with cable rail system is intended to minimize visual disruption to the landscape and be visually distinct from the historic stone arch bridge that dates to the construction of the park.
- The design of the cart boardwalk itself is intended to be attractive and compatible with the naturalistic pond, meadow and woodland landscape that surrounds.

Locus Map:

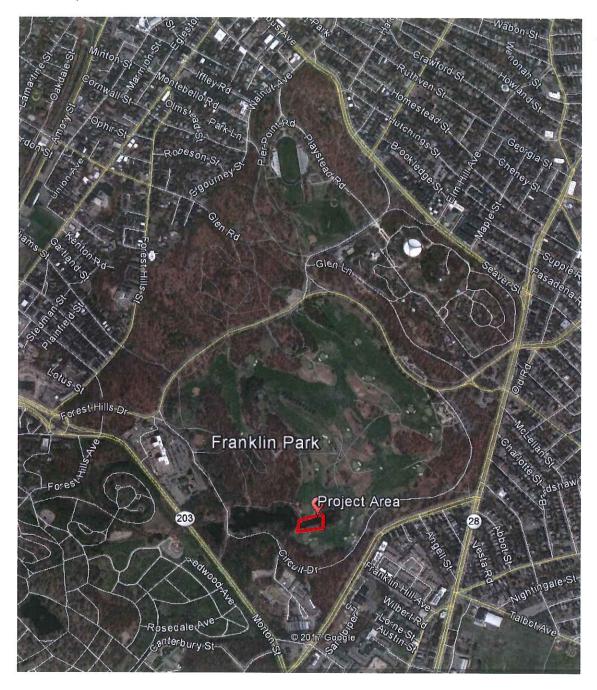

Photos:



Location of the proposed cart boardwalk crossing. 17th back tee is immediately to the right in the photo and 17th front tee, fairway and green are across the pond. 16th golf hole is to the left in the photo. The cart boardwalk would extend from just to the right of the yellow stake in the foreground to the left of the black stake across the pond near the forward tee.



Looking the reverse direction, with the 17th back tee located across the pond and the 16th golf hole located to the right in the photo. The proposed cart boardwalk crossing would connect from about the wooden post in foreground to the right of the back tee across the pond.



The iconic stone arch bridge. The new cart boardwalk will eliminate golf cart related traffic from this bridge and reestablish the historic bridge to pedestrian only traffic.



Fall view showing the project area. The stone arch bridge is located approximately 200' to the left (or west) of the 17th back tee.


Perspective Renderings





View of the proposed cart boardwalk from historic stone arch bridge.




View of the proposed cart boardwalk from the 17th back tee.

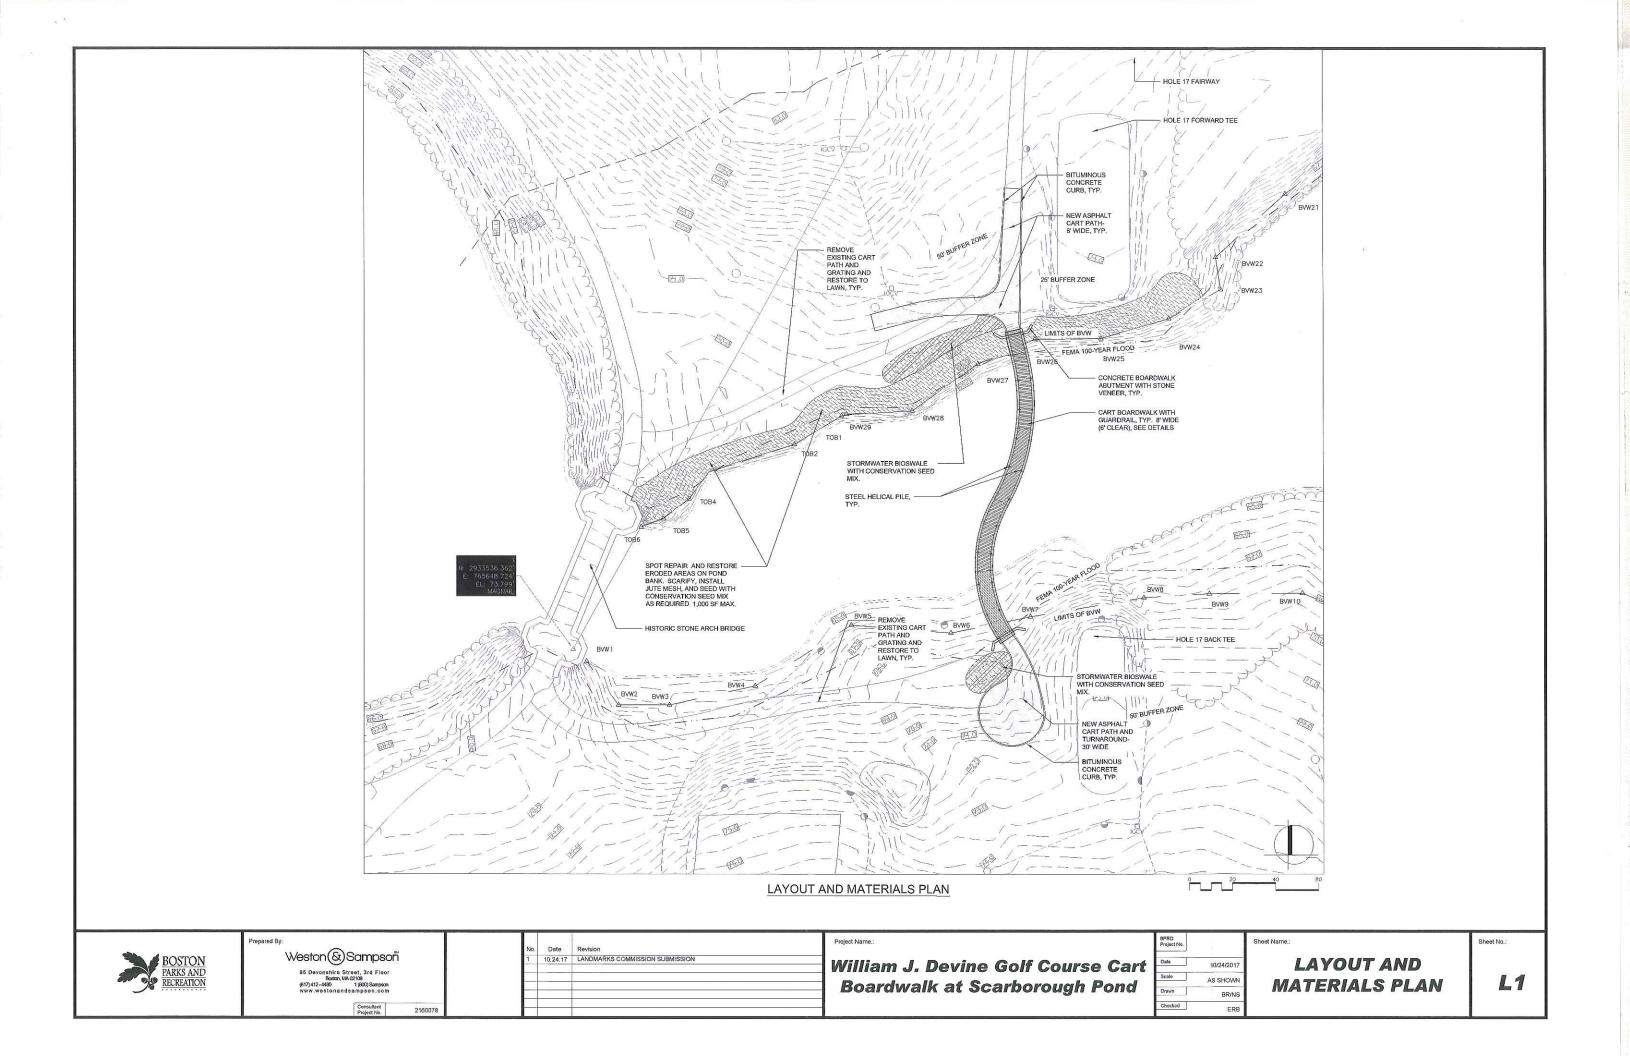

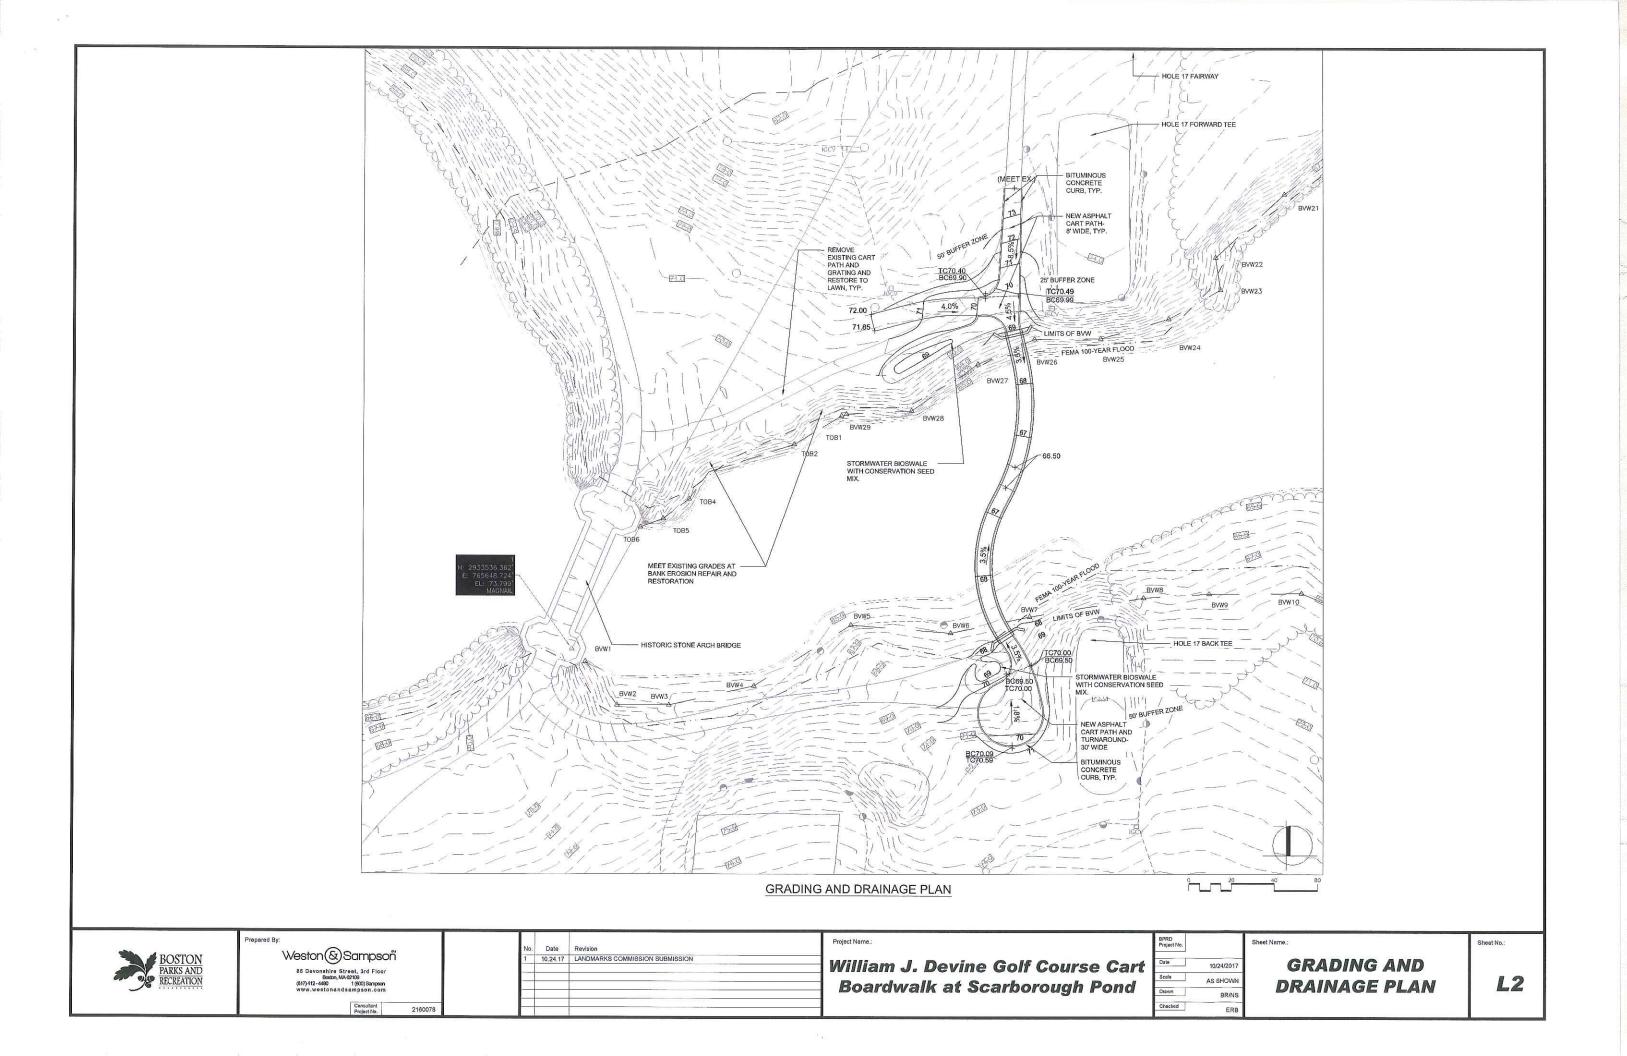

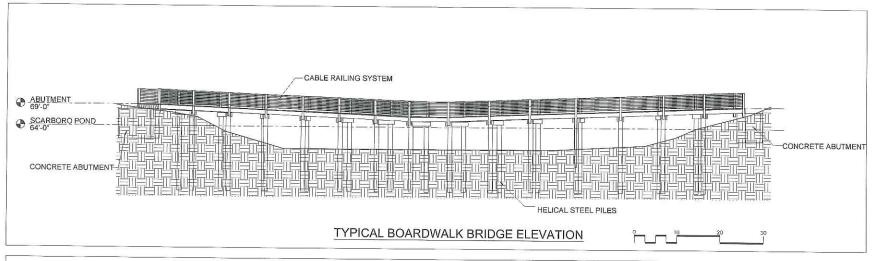

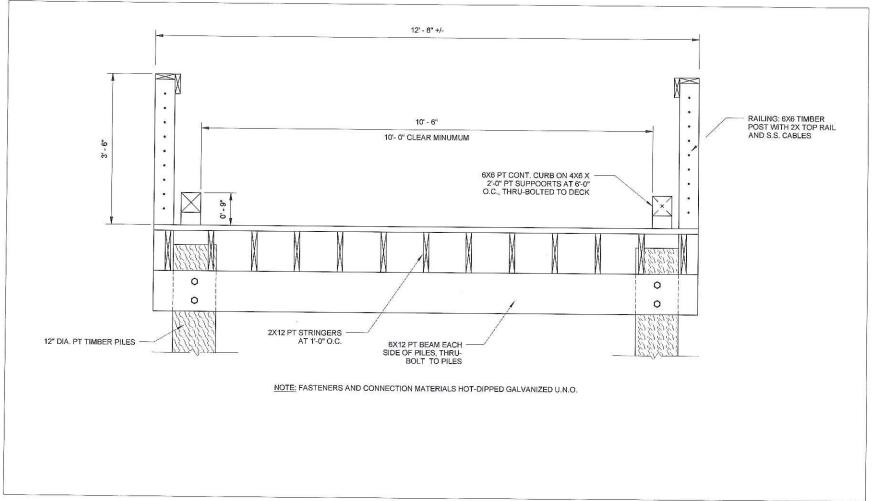

TYPICAL BOARDWALK BRIDGE SECTION







No.	Date	Revision
1	10.24,17	LANDMARKS COMMISSION SUBMISSION
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William J. Devine Golf Course Cart Boardwalk at Scarborough Pond

SPRD Project No.		s
Date	10/24/2017	
Scale	AS SHOWN	
Drawn	BR/NS	
Checked	ERB	

CART BOARDWALK
DETAILS

Sheet No.:

L3



85 Devonshire Street, 3rd Floor, Boston, MA 02109

February 13, 2018

Todd Satter
City of Boston
Environment Department
Landmarks Commission
Boston City Hall Room 709
Boston, MA 02201

RE:

William Devine Golf Course at Franklin Park

Subject:

Cart Boardwalk Crossing of Scarborough Pond- Updated Plans

Dear Mr. Satter:


We are writing you to provide updated plan information for the proposed William J. Devine Golf Cart Boardwalk at Scarborough Pond project, which was originally submitted to your office on November 3, 2017. The plan changes were the result of additional updates required for the Notice of Intent filing with the Boston Conservation Commission as well as additional coordination with a separate Franklin Park pathway improvement project, also being undertaken by Boston Parks and Recreation. We are providing you the relevant plan sheets from the NOI filing for your review, with the specific design changes outlined below:

Addition of Shrub Planting - Sheet L3.00

The revised Layout and Materials Plan show the addition of approximately 58 shrubs, located at the wall abutments for the proposed cart boardwalk. These plants are intended to screen the relatively small wall reveal (12"-30" of exposed face) at the bridge abutment. Using the Muddy River Restoration project as a guide, native plant species were selected and laid out to match historical intent, and blend seamlessly with the surrounding pond bank vegetation.

- As part of the Notice of Intent submission, and in coordination with the Franklin Park pathway improvement project, the "Stormwater Bioswale with Conservation Seed Mix" shown on Sheet L1 our original submission has been changed to a "Sand Filter Swale with Lawn Seed Mix". The intent of the sand filter swale is to capture and treat stormwater run-off from the impervious pathways. The sand filter swales will be located in areas that are currently mown lawn, and the layout and grading of these swales have changed to fit more subtly in to the existing topography.
- Addition of "Cobble Edge at Sand Filter"- L3.00, Sheet L501, Detail 4
 A cobble edge was added where the sand filter swale interfaces with the bituminous concrete cart path. The cobble edge will help dissopate concentrated storm water flows, preventing erosion where run-off enters the sand filter swale. It also serves as a visual edge and tactile edge to help prevent golf carts from straying off the path. The cobble edge will be set in mortar, using salvaged puddingstone blocks to keep a consistent material palette with the surrounding historical context.

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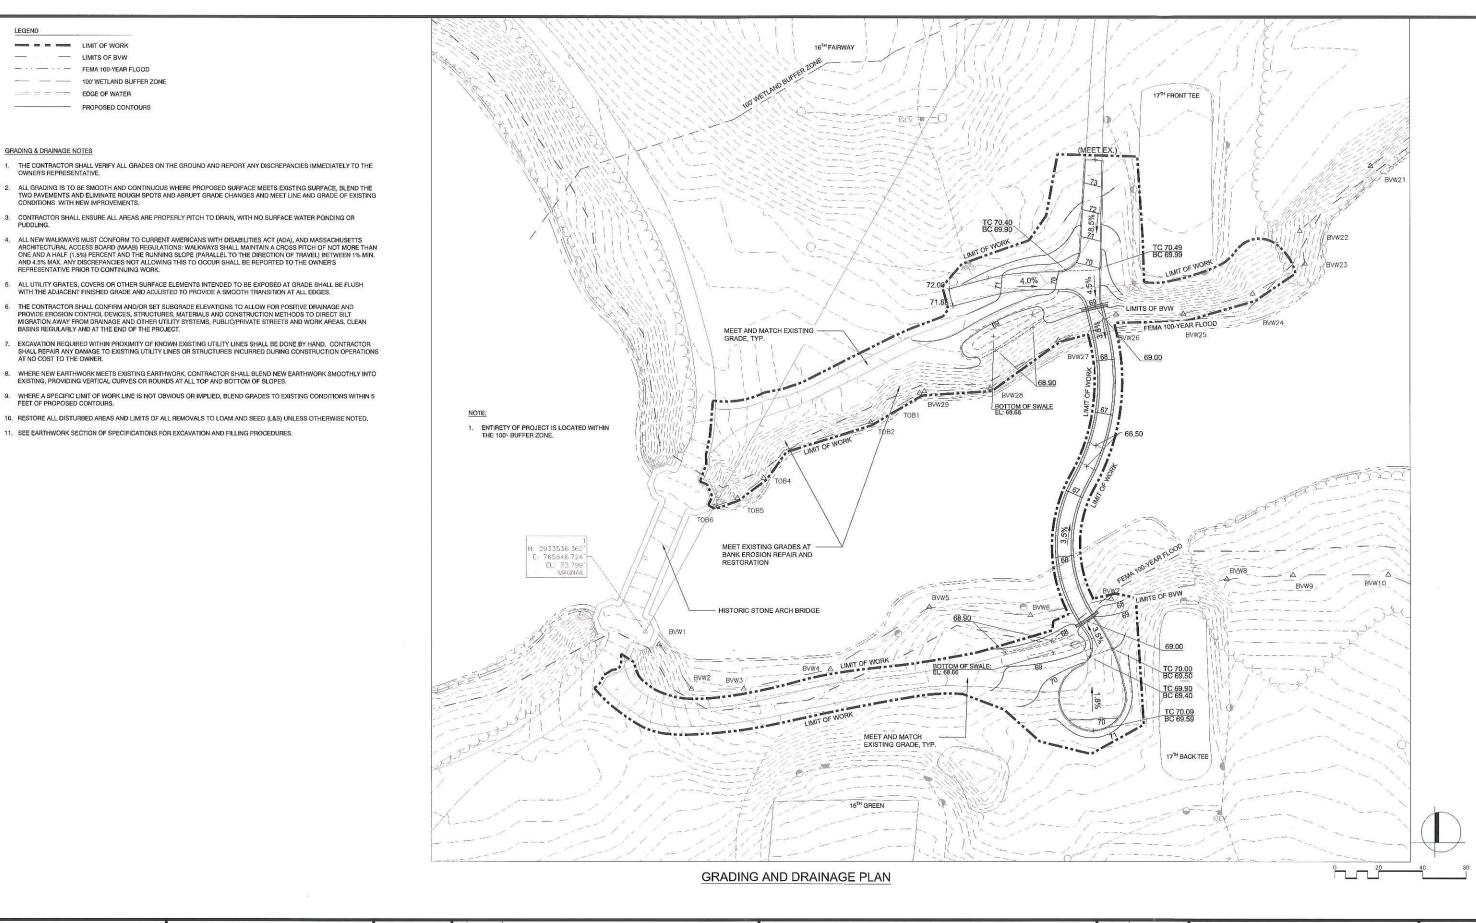
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1	10.24.17	LANDMARKS COMMISSION SUBMISSION
2	02.07.18	N.O.I. SUBMISSION

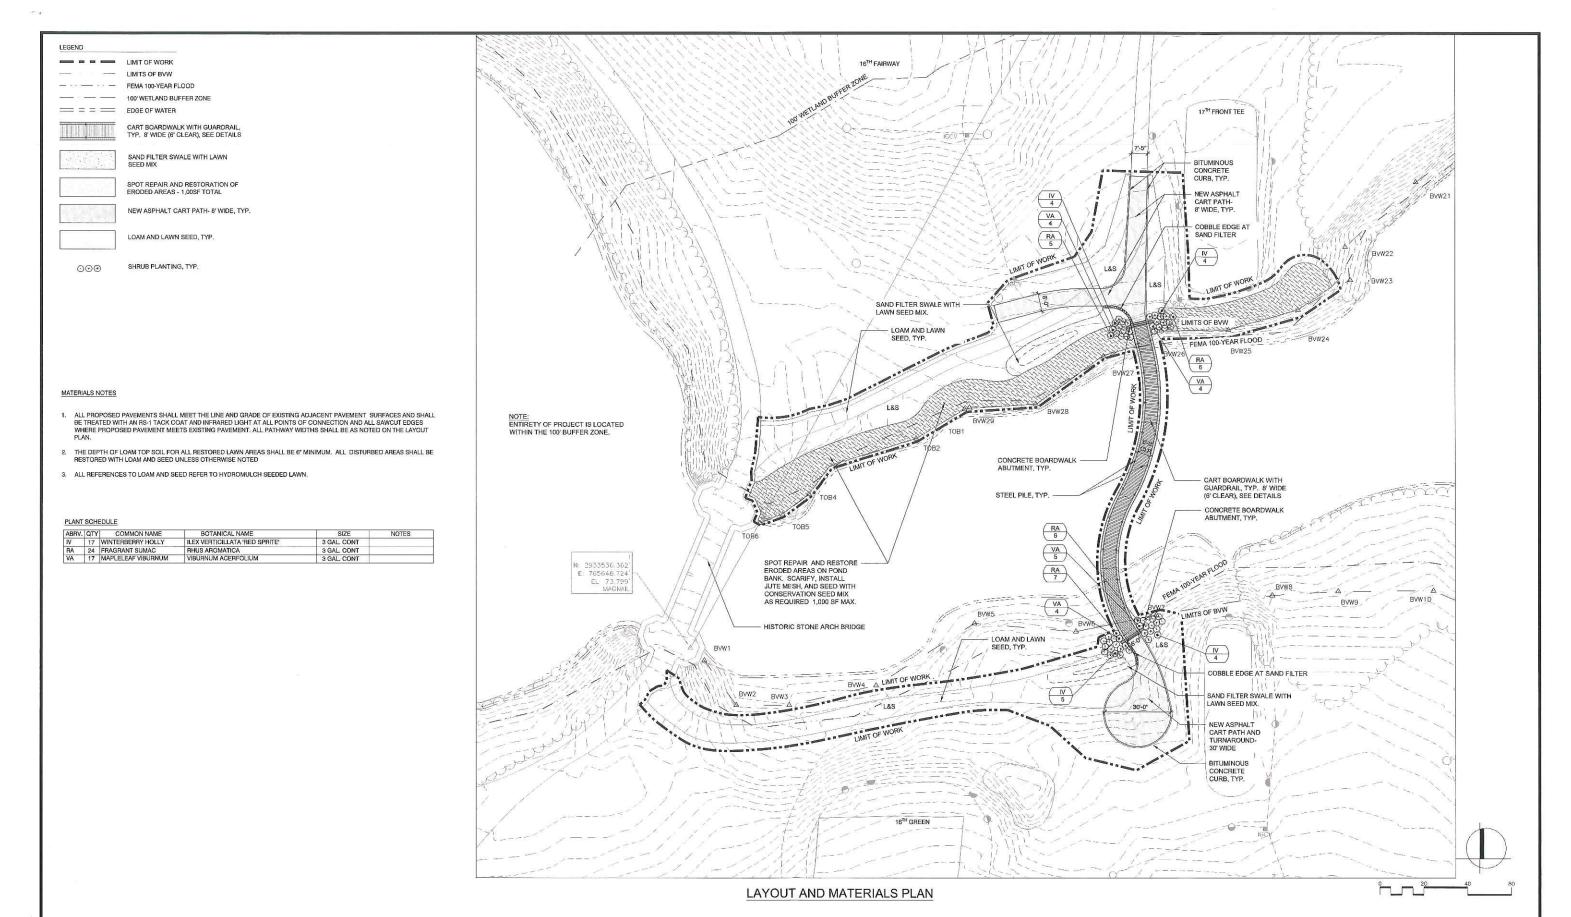William J. Devine Golf Course Cart Boardwalk at Scarborough Pond

02/07/2018 AS SHOWN BR/NS

LAYOUT AND **MATERIALS PLAN**

L300










Date	Revision
10.24.17	LANDMARKS COMMISSION SUBMISSION
02.07.18	N.O.I. SUBMISSION
	10.24.17

William J. Devine Golf Course Cart Boardwalk at Scarborough Pond


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GRADING AND DRAINAGE PLAN L400

Sheet No.:

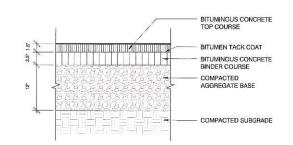


BITUMINOUS CONCRETE PAVING SCALE: N.T.S

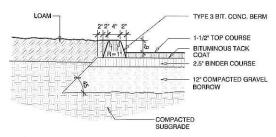

NOTE: SET BIT. CONC. BERM ON BINDER COURSE PRIOR TO INSTALLATION OF TOP COURSE


BITUMINOUS CONCRETE CURB SCALE: N.T.S

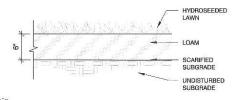

LOAM AND SEED 3


BITUMINOUS CONCRETE PAVING, SEE DETAIL SALVAGED PUDDING STONE COBBLES, TYP.- SIZE VARIES MORTAR JOINT, COLOR TO MATCH STONE. LOAM AND LAWN SEED, TYP. 2" MORTAR SETTING BED ON CONCRETE PAD. - COARSE SAND FILTER LAYER, TYP. VARIES, SEE PLANS OVERFLOW ELEV., SEE PLANS COMPACTED GRAVEL BORROW X 2 MAINTAIN POSITIVE DRAINAGE ACROSS COBBLE EDGE 1:10 SECTION

SAND FILTER WITH COBBLE EDGE

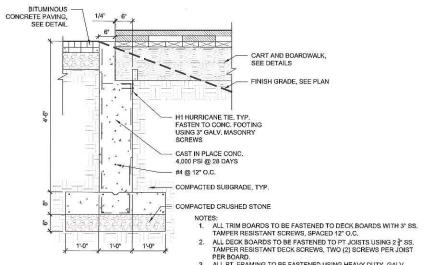

PER BOARD.
ALL PT. FRAMING TO BE FASTENED USING HEAVY DUTY GALV.
HARDWARE AND FASTENERS.

BRIDGE FOOTING DETAIL 5 SCALE: N.T.S

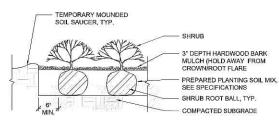

TE:
ALL MULCH MUST BE DARK IN COLOR, PROVIDE SAMPLE PRIOR TO
INSTALLATION TO BE APPROVED BY OWNER'S REPRESENTATIVE.

SHRUB PLANTING SCALE: N.T.S



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10.24.17 LANDMARKS COMMISSION SUBMISSION 02.07.18 N.O.I. SUBMISSION

William J. Devine Golf Course Cart Boardwalk at Scarborough Pond

02/07/2018 AS SHOWN BR/NS ERB

CONSTRUCTION DETAILS

Sheet No.:

L501