
Existing wall to remain Remove existing wall Existing door to be removed Existing door to remain Not In Contract Remove topping slab where hatch is, prep for new flooring material.


1. CONFORM TO THE MASSACHUSETTS STATE BUILDING CODE, 8TH EDITION, MASSACHUSETTS STRETCH ENERGY CODE, 2009 INTERNATIONAL BUILDING CODE, AND ALL LOCAL AND STATE SUPPLEMENTS. 2. CONTRACTOR SHALL COORDINATE SITE RESTRICTIONS AND REQUIREMENTS WITH OWNERS AND SUBMIT AN OPERATIONS, LOGISTICS, AND SAFETY PLAN FOR REVIEW PRIOR TO STARTING WORK. 3. CONTRACTOR SHALL COORDINATE PROTECT THE EXISTING BUILDING AS WELL AS HARDSCAPING AND LANDSCAPING FROM DAMAGE, DUST, DEBRIS, AND UNAUTHORIZED ACCESS THROUGHOUT CONSTRUCTION. CONTRACTOR SHALL REPAIR ANY DAMAGE TO EXISTING CONDITIONS AT NO COST TO THE OWNER. 4. MAINTAIN SAFE ACCESS TO BUILDING AND AGRESS POINTS AT ALL TIMES DURING CONSTRUCTION. PROVIDE OVERHEAD PROTECTION AT ALL TIMES BELOW ACTIVE WORK 5. G.C. TO COORDINATE WITH THE BUILDING OWNER FOR DISPOSAL OF ALL RUBBISH AND DEBRIS CAUSED BY THE PROJECT. ALL COMMON AREAS TO BE KEPT CLEAN AT ALL TIMES. 6. PRIOR TO COMMENCEMENT OF ANY WORK, GC IS TO COORDINATE REMOVAL OF ANY AND ALL PLUMBING, ELECTRICAL, MECHANICAL AND/ OR ARCHITECTURAL ITEMS, INCLUDING WALL PARTITIONS WITH ALL SUBSTRATES. 7. BUILDING MATERIALS AFFECTED BY THE WORK OF THIS PROJECT MAY CONTAIN HAZARDOUS MATERIALS SUCH AS ASBESTOS (EXAMPLE, IN BUILT-UP ROOFING FELTS AND FLASHINGS) OR PCBS (EXAMPLE, SEALANTS). CONTRACTOR SHALL ENGAGE IN INDUSTIRAL HYGIENIST TO TEST FOR THE PRESENSE OF HAZARDOUS MATERIALS AND ASSIST WITH REMOVAL AND/ OR CONTAINMENT PROGRAM. 8. PRIOR TO COMMENCEMENT OF ANY WORK, GC IS TO VERIFY ALL EXISTING CONDITIONS AND REPORT ANY DISCREPANCY FROM CONDITIONS AND DIMENSIONS INDICATED ON THE

9. ALL FINISHES, MATERIALS, SYSTEMS ETC. WHICH ARE TO REMAIN ARE TO BE PROTECTED

DEMOLITION NOTES:

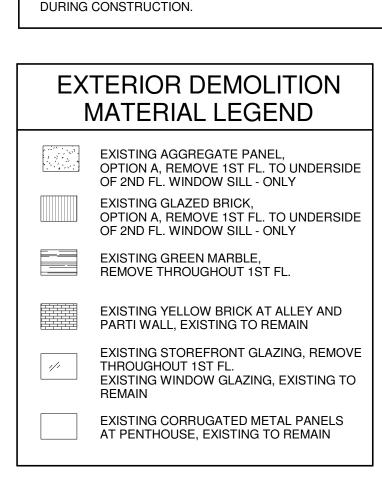

DRAWINGS TO THE ARCHITECT IMMEDIATELY.

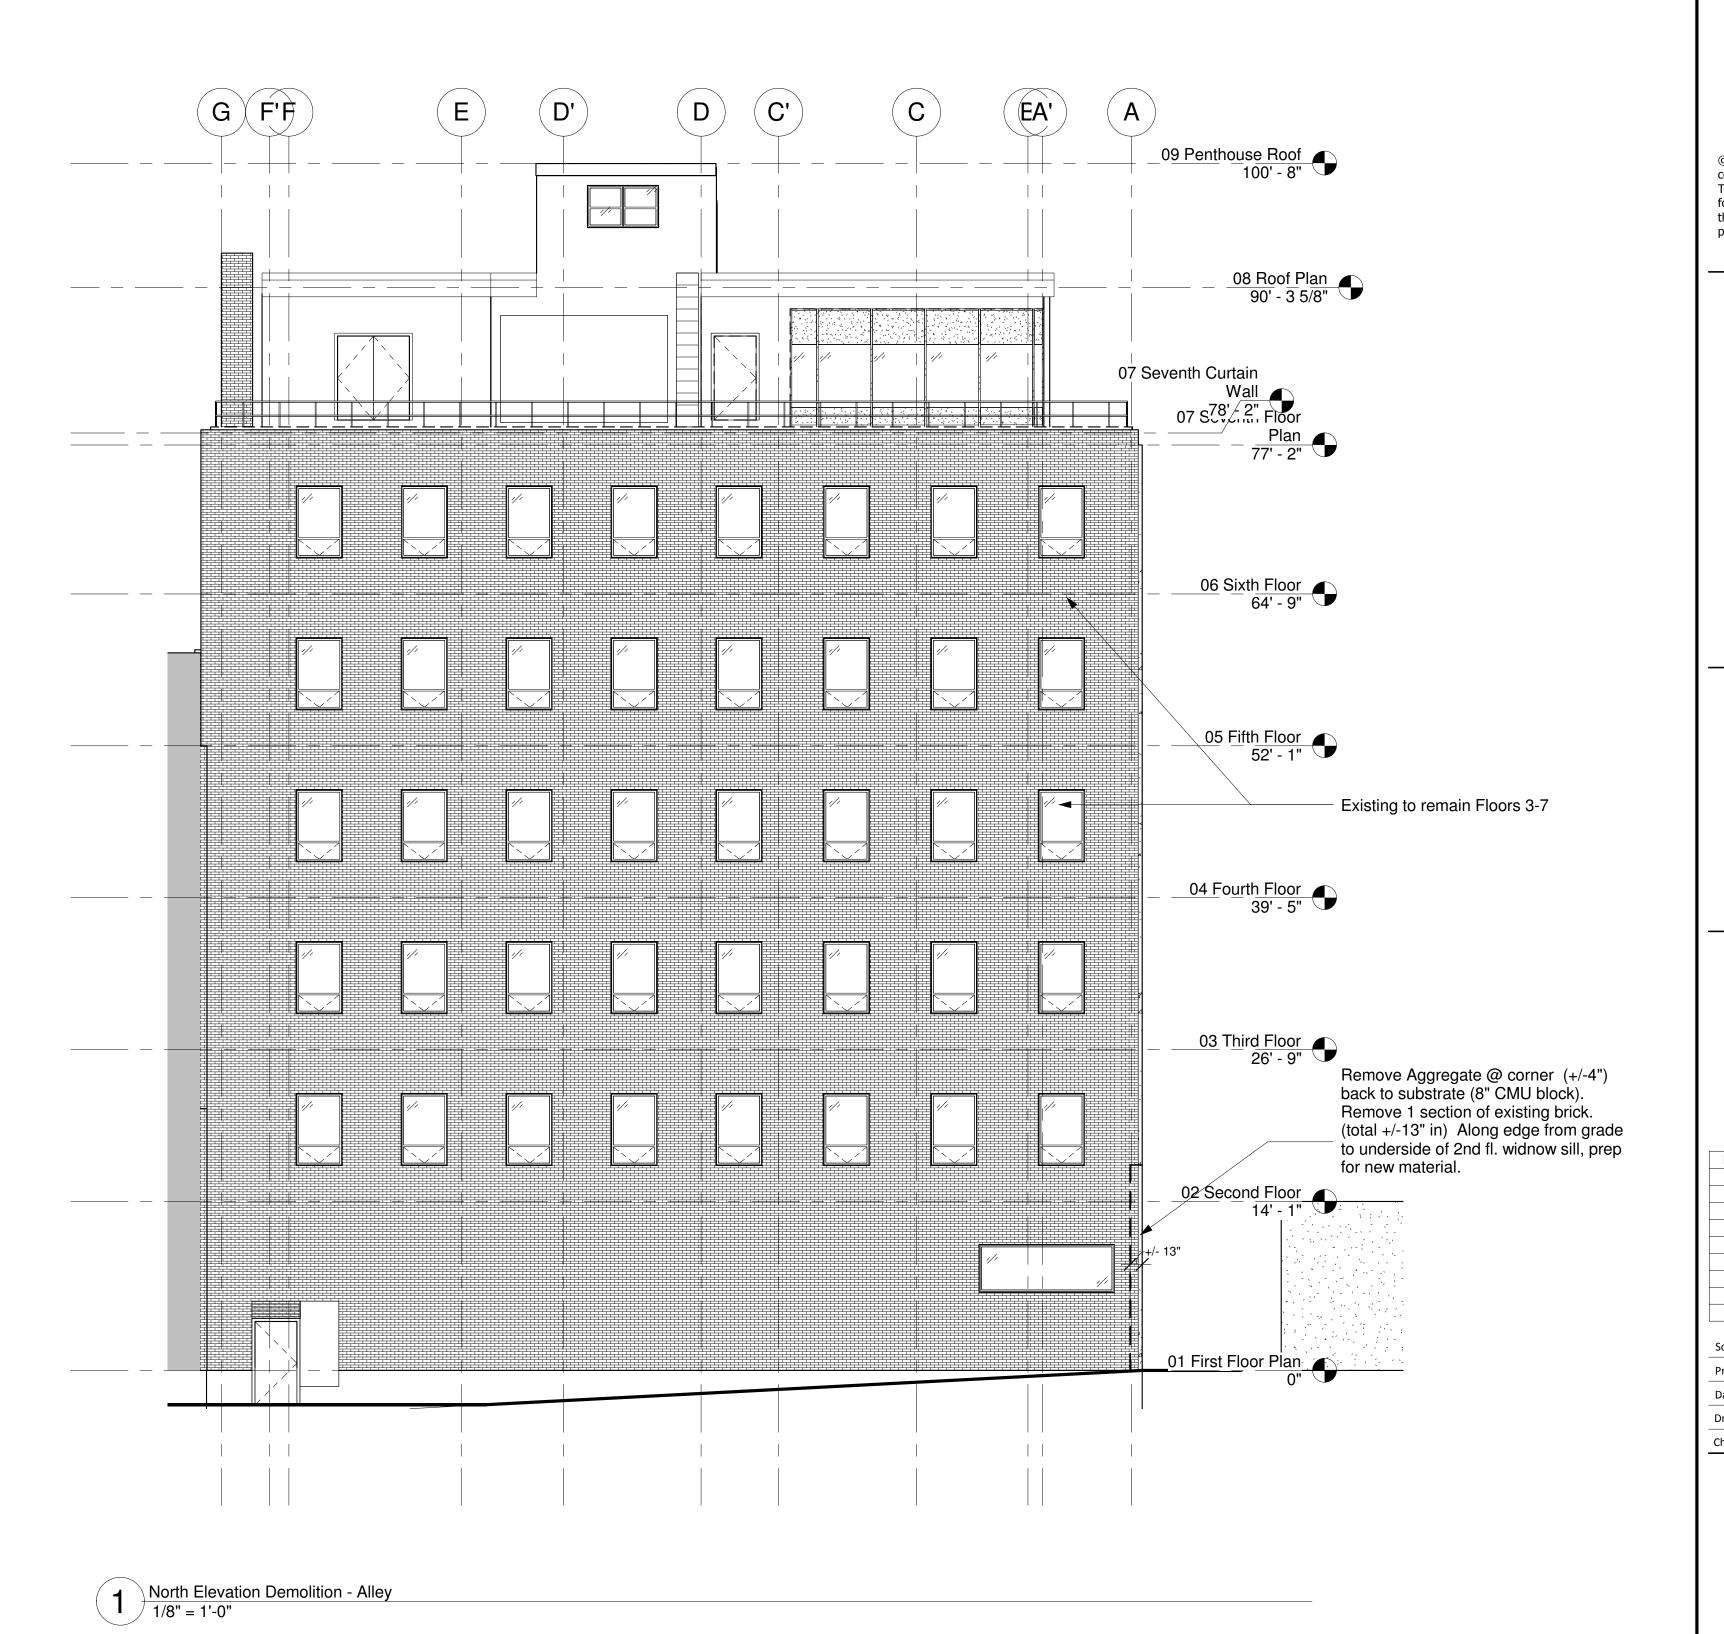

607 Boylston Phase - 1

Boylston Street

Boston, MA

© Silverman Trykowski Associates, Inc. expressly reserves its common law copyright and other property rights in these plans. These plans are not to be reproduced, changed or copied in any form or manner whatsoever nor are they to be assigned to any third party without first obtaining the expressed written permission and consent of Silverman Trykowski Associates, Inc.



21 Drydock Avenue 7th Floor West Boston, MA 02210 t: 617.426.5401 f: 617.426.5491

www.sta-design.com

L

Description Date


2014.64

07/10/2014

Scale
Project Number
Date
Drawn by
Checked by

D-303

North Elevation
Demolition - Phase 1

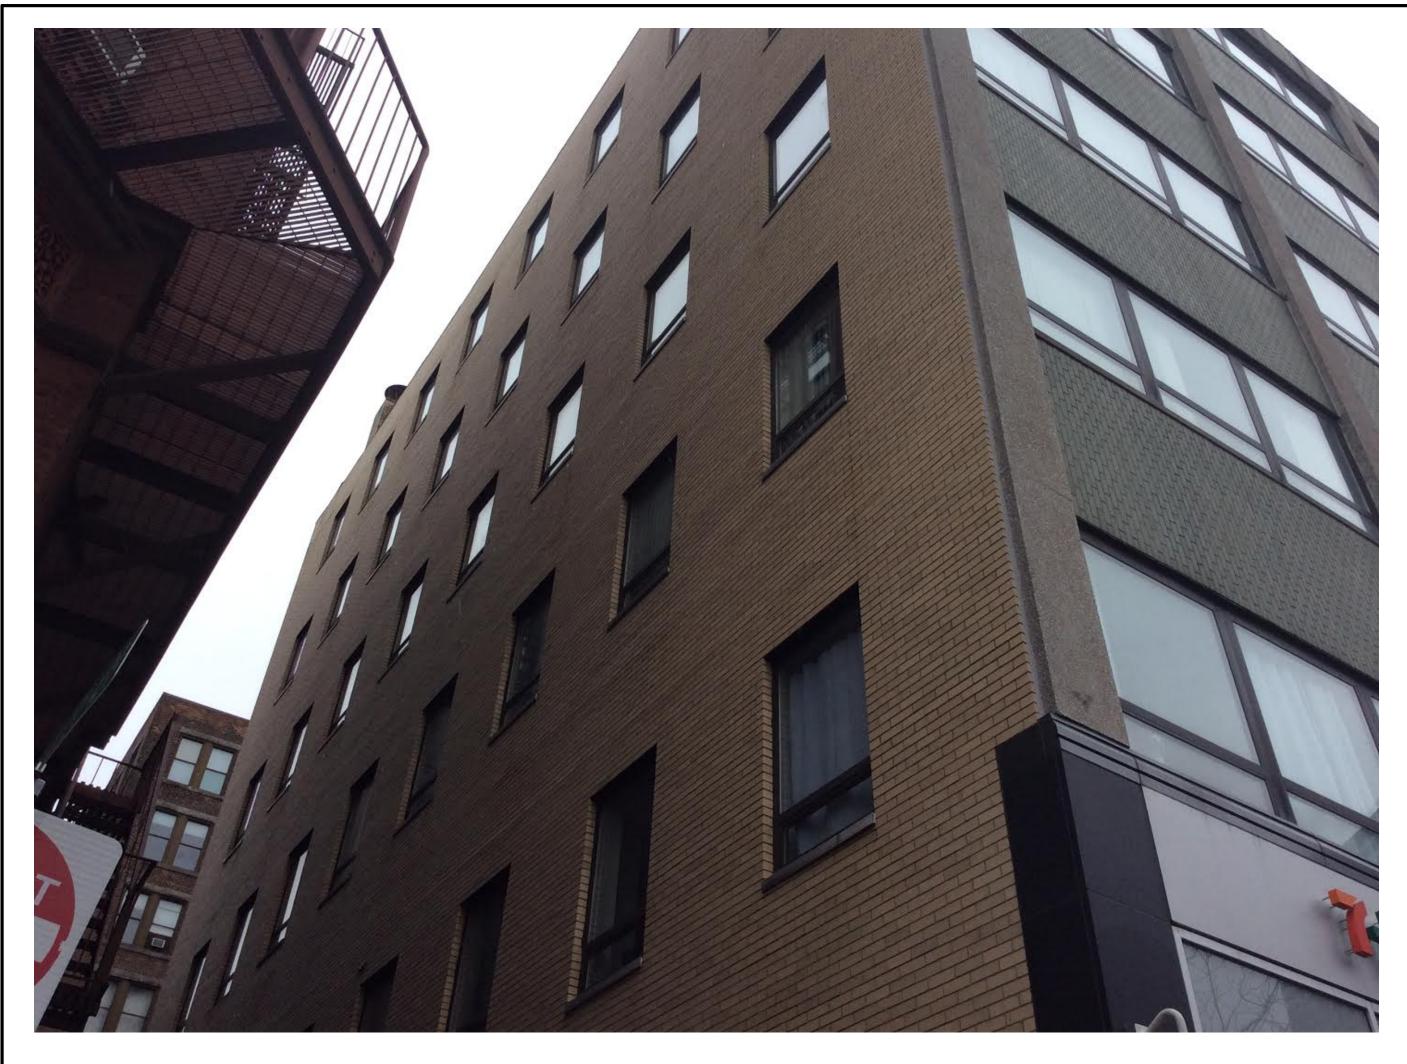





607 **BOYLSTON STREET**



3900 Dr. Greaves Rd.

Kansas City, MO 64030

(816) 761-7476

• FAX (816) 765-8955

ELF375DX and ELF375DXH DRAINABLE STATIONARY LOUVERS EXTRUDED ALUMINUM

STANDARD CONSTRUCTION

FRAME

4" (102) deep, 6063T5 extruded aluminum. ELF375DX - .081" (2.1) nominal wall thickness. ELF375DXH - .125" (3.2) nominal wall thickness. Downspouts and caulking surfaces provided.

BLADES

6063T5 extruded aluminum.

ELF375DX - .081" (2.1) nominal wall thickness. ELF375DXH - .125" (3.2) nominal wall thickness. Drainable blades are positioned at 371/2° angle and spaced approximately 53/32" (129) center to center.

5/8" x .040" (16 x 1) expanded, flattened aluminum bird screen in removable frame. Screen adds approximately 1/2" (13) to louver depth.

FINISH Mill.

MINIMUM SIZE

12"w x 12"h (305 x 305).

APPROXIMATE SHIPPING WEIGHT ELF375DX - 4 lbs./ft.² (19.5 kg/m²).

ELF375DXH - 6 lbs./ft.2 (29.3 kg/m2).

MAXIMUM FACTORY ASSEMBLY SIZE Single sections shall not exceed 120"w x 90"h (3048 x

2286) or 90"w x 120"h (2286 x 3048). Louvers larger than the maximum single section size will require field assembly of smaller sections.


BLADE SUPPORTS


Louvers may be provided with rear mounted blade supports that increase overall louver depth depending on louver size, assembly configuration or windload.

Consult Ruskin for additional information.

LEED Material Information

Contact Ruskin for Recycled Material and Manufacturing Location Information.

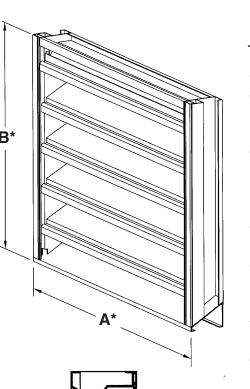

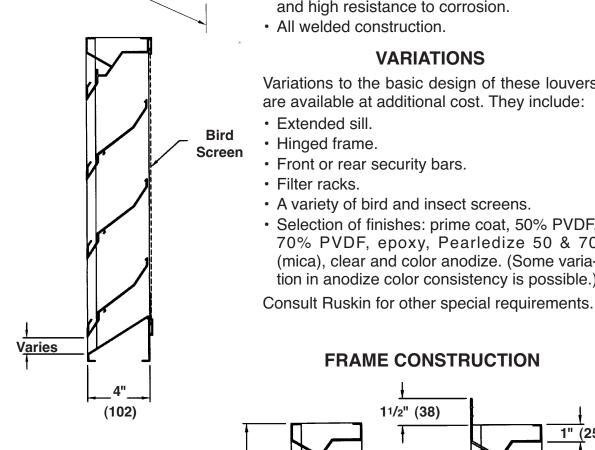

FEATURES The ELF375DX and ELF375DXH offers: 54% Free Area. Published performance ratings based on testing in accordance with AMCA Publica-


- tion 511. · High performance frame system with drainable head collects and removes water to provide excellent water penetration perfor-
- Drain gutter in each blade minimizes water cascade between blades.
- · Architecturally styled, hidden mullions allowing continuous line appearance up to 120"
- Aluminum construction for low maintenance and high resistance to corrosion.

All welded construction. **VARIATIONS**

Variations to the basic design of these louvers are available at additional cost. They include:

- Extended sill.
- Hinged frame.
- Front or rear security bars.
- Filter racks.
- A variety of bird and insect screens.
- Selection of finishes: prime coat, 50% PVDF, 70% PVDF, epoxy, Pearledize 50 & 70 (mica), clear and color anodize. (Some variation in anodize color consistency is possible.)

FRAME CONSTRUCTION

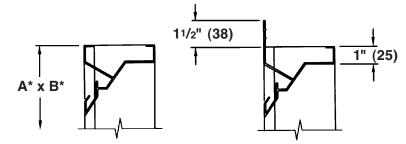


INTEGRAL FLANGE

Dimensions in inches, parenthesis () indicate millimeters. *Units furnished 1/4" (6) smaller than given opening dimensions.

TAG	QTY.	SIZE		FRAME	VARIATIONS
		A*-WIDE	B*-HIGH		
PROJECT					LOCATION
ARCH./ENGR.					CONTRACTOR
REPRE	SENTATI	IVE			DATE

Spec ELF375DX/ELF375DXH-513/Replaces ELF375DX/ELF375DXH-610 ALL STATED SPECIFICATIONS ARE SUBJECT TO CHANGE WITHOUT NOTICE OR OBLIGATION.

© Ruskin May 2013

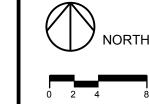

Silverman Trykowski Associates, Inc. expressly reserves its common law copyright and other property rights in these plans. These plans are not to be reproduced, changed or copied in any form or manner whatsoever nor are they to be assigned to any third party without first obtaining the expressed written permission and consent of Silverman Trykowski Associates, Inc.



617 • 426 1501

21 Drydock Avenue 7th Floor West Boston, Ma 02210 fx: 617 . 426 . 5491 www.sta-design.com

Drawn By TT	Ck'd By	TT	
Date			4/4/
Revisions			
\triangle			
			+
			1

A-101 **607 IMAGES**

Scale **1/8" = 1'-0"** CADD # **2003.06**

PROPOSED ELEVATION FINISH LEGEND Material Aluminum Composite Panel Color A Alpolic Color: Mica MZG Grey Material Aluminum Composite Panel Color C - Interior/ Exterior Ceilings ONLY or equal Apolic Color: BNT White or equal Stone Stone Source Contact - Brian Vogel 617.671.0900 1 1/2" Thick Stone Granite Nordic Black Flamed Finish 0" - 48" AFF Align w/ mullions Granite Nordic Black Brushed (smooth finish) 48" - 192" AFF Verify in field stone dimensions. *DO NOT ALLOW RESIN FILLED HOLES IN STONE TO AVOID DISCOLORATION. **METAL PANEL NOTES:** ALL NEW METAL PANELING ALIGNS WITH EX. WINDOWS AND MATERIAL CHANGES, TYPICAL THROUGHOUT ELEVATIONS. 1/2 " REVEALS STANDARD THROUGHOUT METAL PANELING ALL OF THE METAL PANEL WALL SYSTEMS WILL INCLUDE A DEDICATED AIR, WATER AND VAPOR BARRIER MEMBRANE(i.e., SELF-ADHERED RUBBERIZED ASPHALT MEMBRANE) ON THE OUTBOARD SURFACE OF THE EXISTING BACKUP WALLS. THE MEMBRANE WILL BE INTEGRATED AT ALL PERIMETER CONDITIONS AND TRANSITIONS TO PROVIDE CONTINUITY OF THE AIR, WATER AND VAPOR BARRIER SYSTEMS.

IF PANELS CALL FOR **HORIZONTAL** HAT CHANNEL OR STEEL GIRT CONNECTIONS

OF CONTINUOUS EXTERIOR INSULATION IN ABOVE GRADE MASS WALLS.

NOTE: SEE METAL PANEL SCHEDULE FOR MORE INFORMATION ON

WALL TO REDUCDE THERMAL BRIDGING.

SPECIFICATIONS.


MINERAL WOOL INSULATION AGAINST THE AIR, WATER, AND VAPOR BARRIER

SHIMMING BEHIND IS REQUIRED, SO WATER CAN TRAVEL DOWN THE WATERPROOFING MEMBRANE UNIMPEDED. IN VERTICAL CONNECTION CONDITIONS NOT REQUIRED.

THE MA STRETCH ENERGY CODE, WHICH APPLIES TO THE PROJECT, REQUIRES R-13.3

IN AREAS WHERE UNINSULATED PANELS ARE SCHEDULED PROVIDE A MINIMUM 3 1/2" OF

MEMBRANE. ANOTHER 1" OF SPRAY FOAM INSUALTION ON THE INBOARD SIDE OF THE

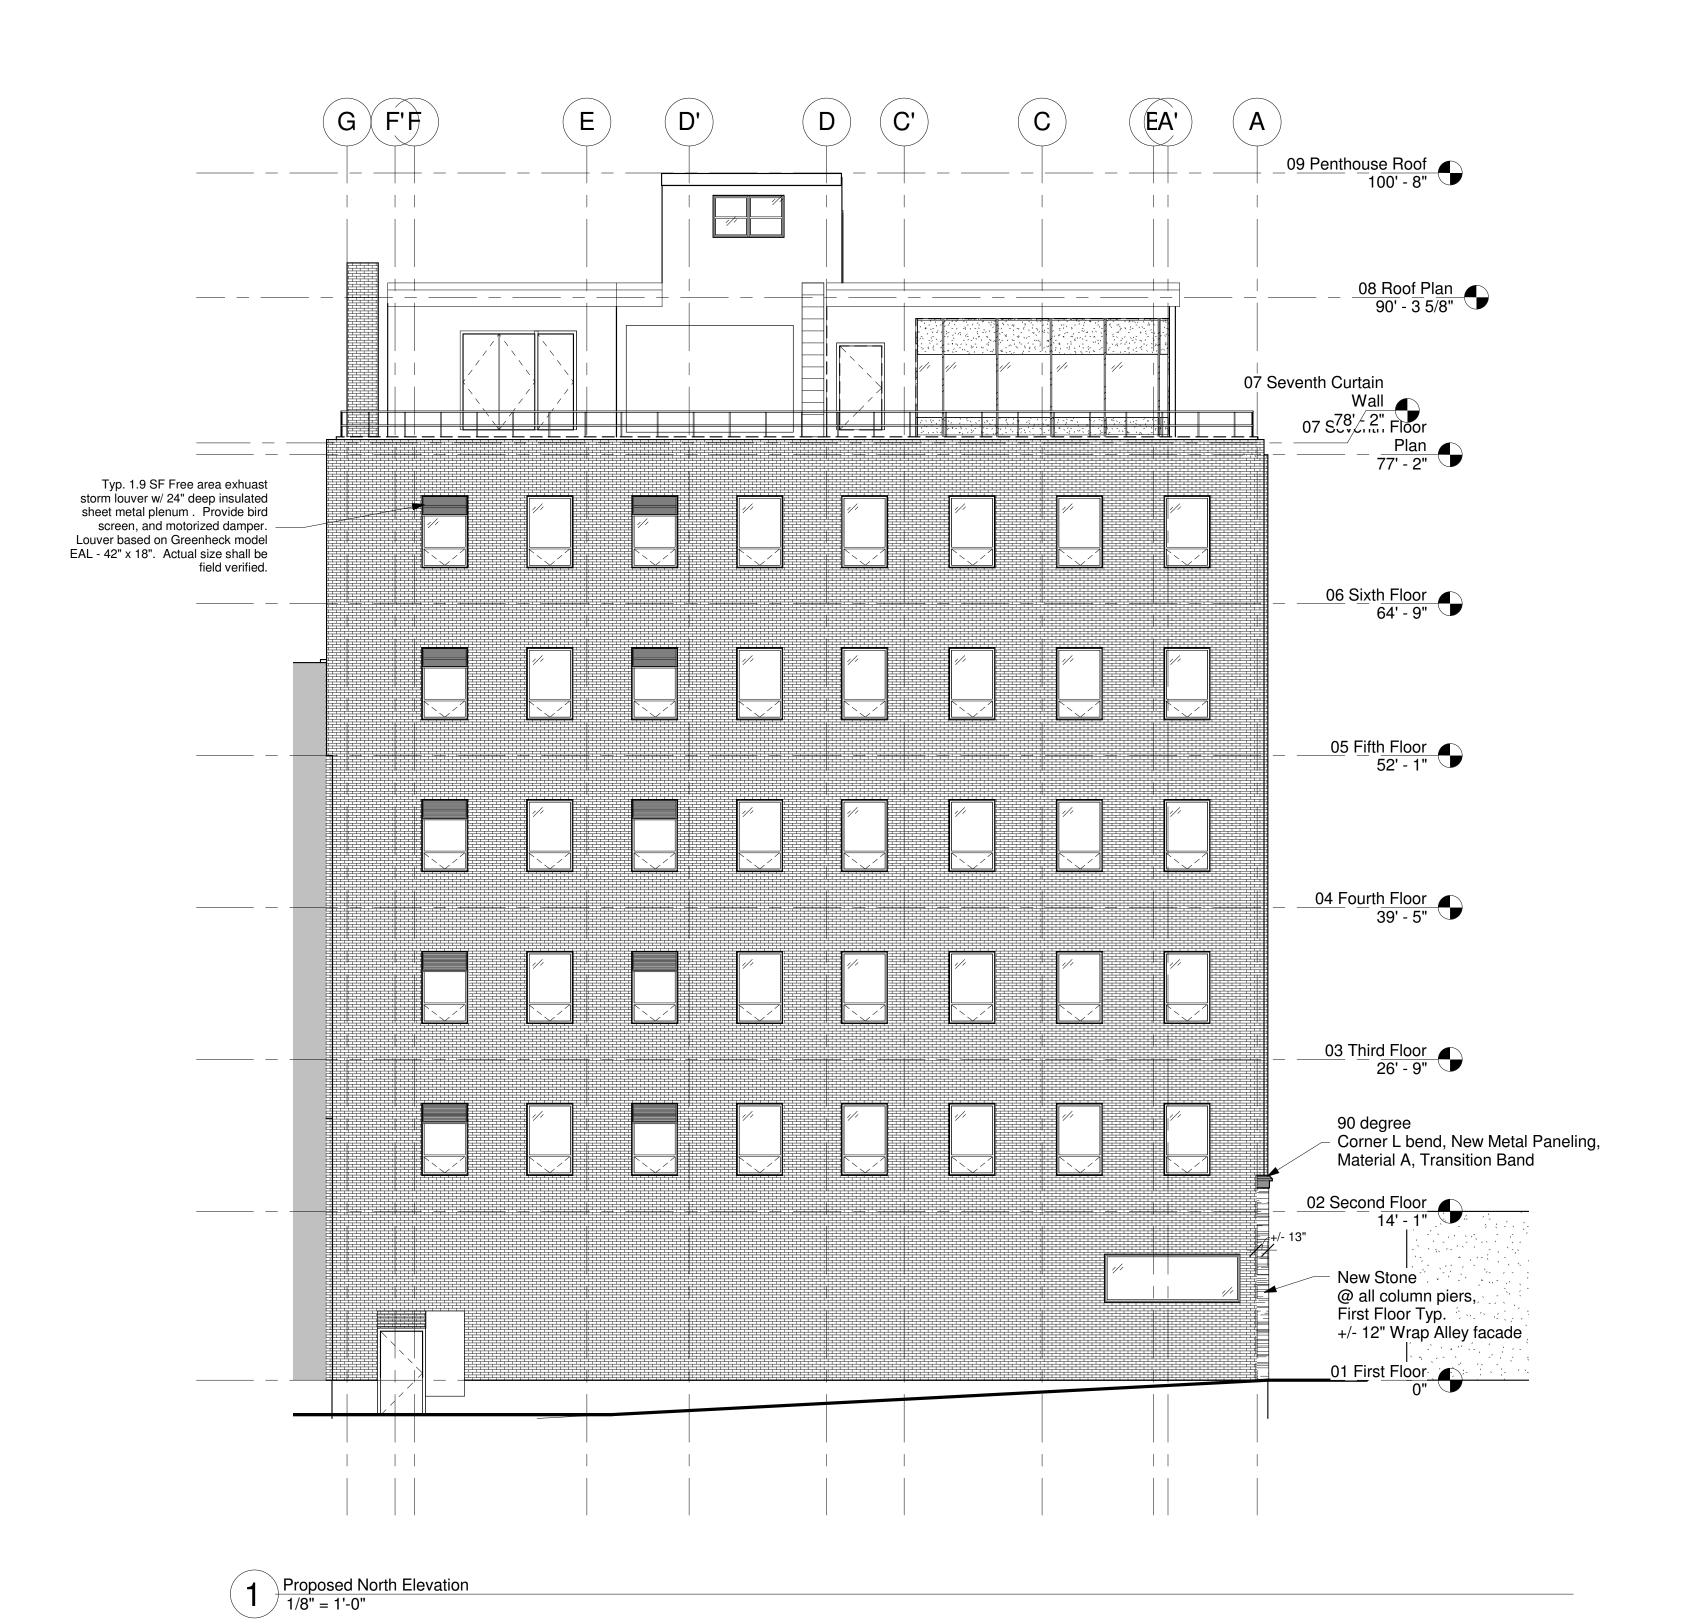

607 Boylston Phase - 1

Boylston Street

Boston, MA

© Silverman Trykowski Associates, Inc. expressly reserves its common law copyright and other property rights in these plans. These plans are not to be reproduced, changed or copied in any form or manner whatsoever nor are they to be assigned to any third party without first obtaining the expressed written permission and consent of Silverman Trykowski Associates, Inc.



21 Drydock Avenue 7th Floor West Boston, MA 02210 t: 617.426.5401 f: 617.426.5491

www.sta-design.com

__

Description Date 1/8" = 1'-0" 2014.64 Project Number 10/23/2014 Drawn by

Proposed Exterior North Elevation - Phase 1

Checked by