

BHAC Application – Supplemental Information


Date: 3/9/17

7 Acorn Street

PM/Author: Adam Wylie - Mayhew PMC


Distribution: BHAC


Existing Conditions:

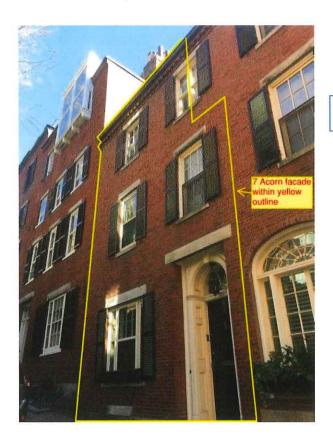


Front façade visible from Acorn Street

Rear façade visible from W. Cedar Street

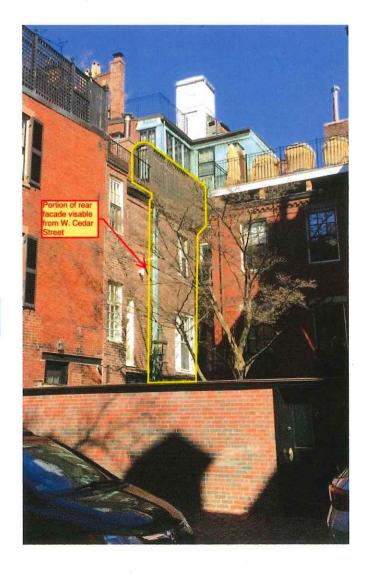

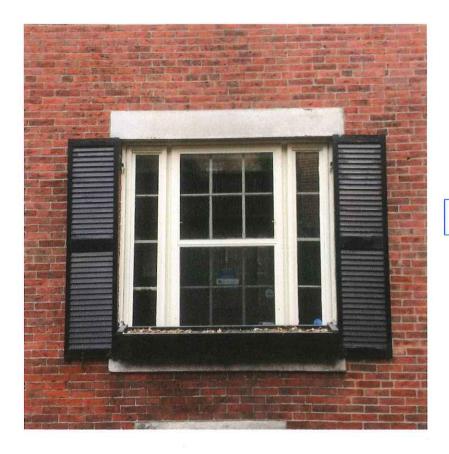

Typical window from exterior

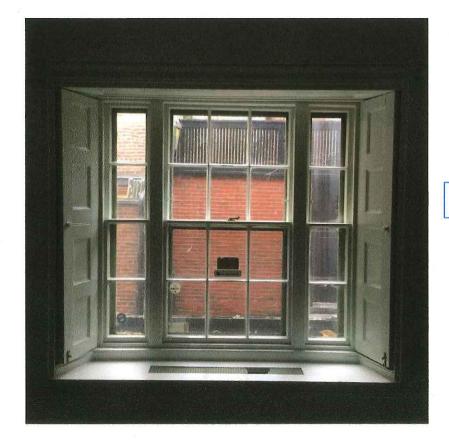

Typical window from interior



Existing frames are out of square, making windows inoperable and difficult to repair

Rotting sills and deteriorated jambs. Lead paint peeling and flaking





Existing frames are out of square, making windows inoperable and difficult to repair



BHAC Application – Additional Information Requested

Date: 3/27/17

7 Acorn Street

PM/Author: Adam Wylie – Mayhew PMC

Distribution: BHAC

MAR 28 2017

• <u>FEE</u>: Per the <u>Instructions/Fee</u>, the fee for window replacement and roof decks are \$50. Please submit a new check or money order for \$50 made payable to "City of Boston".

The corrected amount will be submitted with this additional information.

• SCOPE OF WORK: Please confirm in writing whether or not the existing storm windows are to be retained...if you are proposing to install insulated windows it is recommended that the exterior storm windows be removed permanently. Also confirm whether or not the existing wood brick molds are to be retained and restored, or replaced in-kind. If they are to be replaced then you will need to make sure that both your existing and proposed window drawings reflect the accurate profile of the historic wood brick mold.


Since we are proposing the replacement windows to have insulated glass, we would be happy to remove the existing storm windows permanently, as requested.

While every effort will be made to reuse the existing wood brick molds, it is likely that they will need to be replaced when the old windows come out. If this is the case, we intend to match the existing brick mold in kind with the same profile. Here is a photo of the existing brick mold and our best guess at the profile. Once we are able to cut out a piece and clean off layers of paint, we will match exactly:







Brick Moulding Profiles (These profiles are not at actual size at this time.)

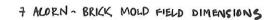

1-11/16"

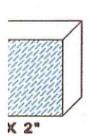




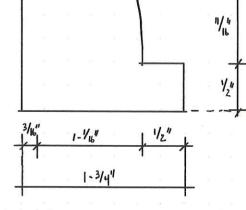

BM 20


- <u>COLOR PHOTOS</u>: Existing conditions of the roof deck (taken from on the roof), window brick mold/jamb.
 - o I've attached a sample photograph in .pdf format for reference of the type of photo I am looking for in regards to the brick mold.



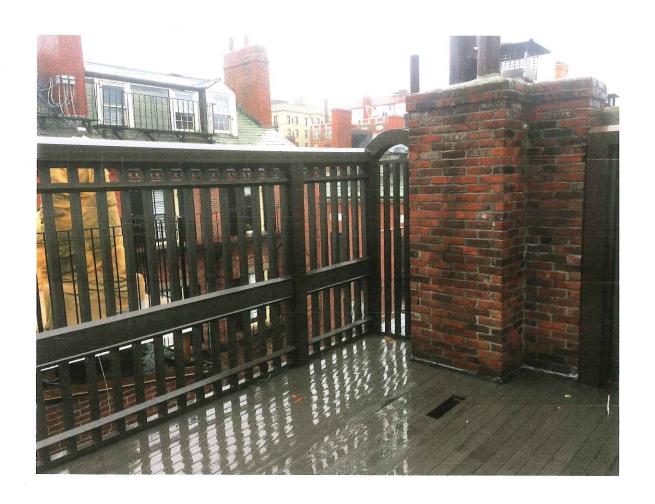



Neighbor's adjoining roof deck. New railing to match this railing style and color

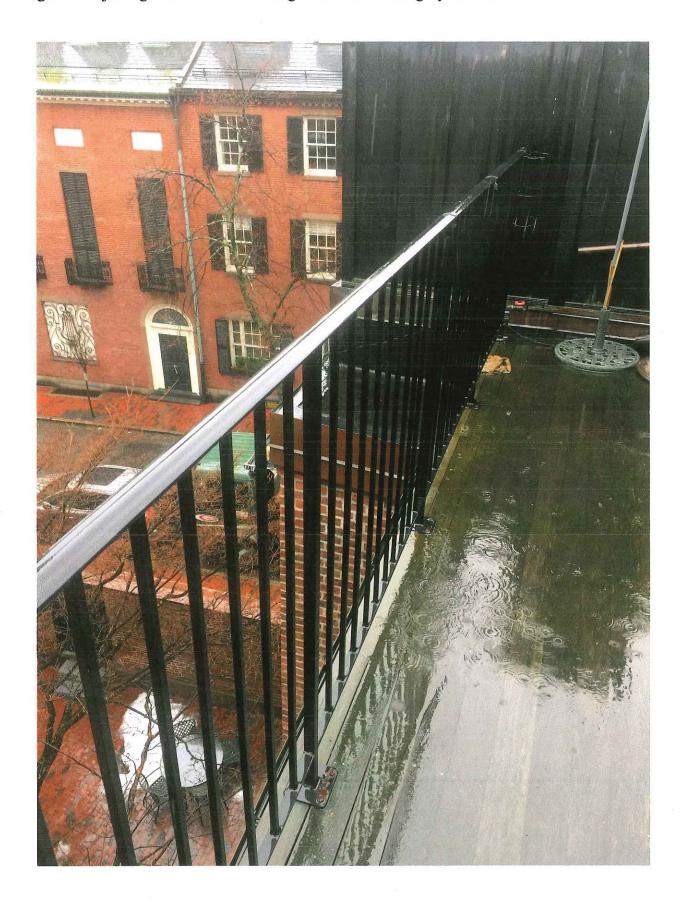

• <u>DRAWINGS</u>: Need dimensioned roof plan, section and elevation drawings detailing the setbacks from the facades and heights from the finished roof.


Please see attached drawings

From the submitted photographs, it appears that the existing roof deck is made of wood with wood railings. It is recommended that the proposed replacement roof deck have metal railings with a dark finish that have a smaller profile to help reduce the visibility.


We will replace the wood railing with a metal railing painted black to match the profile and color of the adjoining roof deck (see previous photo)

o The Commission will be interested in the details of the deck apron/fascia given the level of visibility (hence the need for the elevation and section drawings). If the existing roof deck is right at the edge of the rear facade I'd consider pushing it back a little bit to help break up the massing.

We would be happy to pull the roof deck in 1' from both roof edges to break up the massing. See attached plan and profile/section

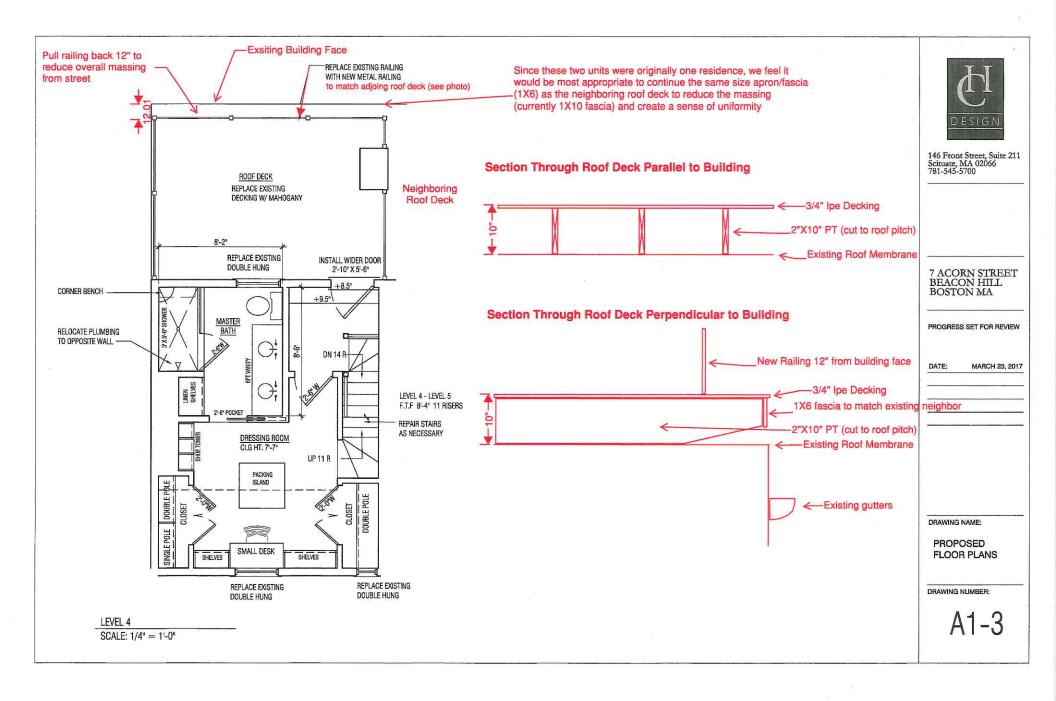


Existing Conditions of Typical Window

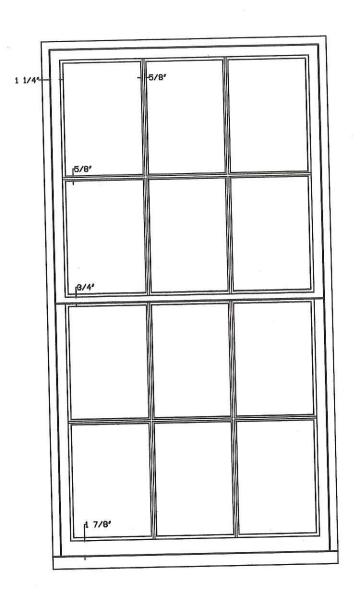


TYPICAL EXISTING DOUBLE HUNG


ELEVATION & SECTION

SCALE: 1" = 1'-0"

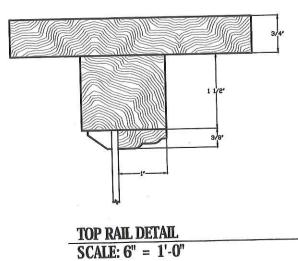


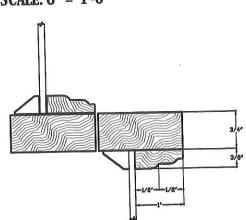



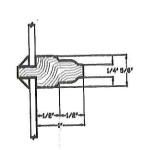

TYPICAL MUNTIN DETAIL
SCALE: 6" = 1'-0"

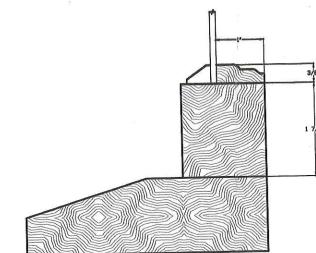

SILL & BOTTOM RAIL DETAIL
SCALE: 6" = 1'-0"



146 Front Street, Suite 211 Scituate, MA 02066 781-545-5700

7 ACORN STREET BEACON HILL BOSTON MA

BEACON HILL ARCHITECTURAL COMMISSION APPLICATION

DATE: MARCH 7, 2017


DRAWING NAME:

EXISTING WINDOW ELEVATION & DETAILS

DRAWING NUMBER:

SK-1

Sample Shop Drawing from Boston Sash - exact dimesnions, sizes and quantities to be committed upon ordering STANDARD - 5-1/2" UNIT DEPTH - ANNEALED SINGLE STRENGTH GLASS, INSULATED GLASS UNIT - UTILE MAHOGANY FRAME & SASH - STANDARD 1-1/2" THICK WESTERN RED CEDAR SILLS FAX # (508)880-8828 WWW,BOSTONSASH.COM - PRIMED EXTERIOR/ RAW INTERIOR - AMESBURY CONCEALED BALANCES - FULLY WEATHER SEALED - 7/8" S.D.L. MUNTIN GRILL CONFIGURATIONS $45\frac{5}{32}$ " R.O.H. — $45\frac{3}{32}$ " U.H. — $-41\frac{15}{32}$ " S.O.H. STD. HARDWARE SIZING AMESBURRY 186 CONCEALED BALANCES - U.W. = G.W.+5-1/2" - S.O.W.=G.W.+4" - O.A.S.W.= G.W.+3-9/16" 21³, L.S.H. - D.L.O.W.=G.W.-9/16" - U.H. = (U.G.H.+L.G.H.)+9-3/82" HST. SILL STD. SILL - S.O.H.= (U.G.H.+L.G.H.)+5-15/32" - U.S.H.=U.G.H.+3-1/32" N/A - L.S.H.=L.G.H.+3-3/4" DEALER -D.L.O.H.=G.H.-9/16" N/A CONTRACTOR N/A ARCHITECT **OPTIONAL ITEMS** EGRESS INFO. N/A BEACON HILL D.H. B.B.U. PROJECT MANAGER · 2" PINE OR UTILE MAHOGANY INT.EXTENSION JAMBS - MINIMUM UNIT SIZES TO PASS 20"X24" C.O. MA. EGRESS N/A TEMPERED DOUBLE STRENGTH GLASS UNITS DRAWN BY: - SIZES BASED ON STANDARD 3/4" THICK WINDOW STOOL KEITH KUTHAN ARGON INSULATION GAP AND A 1-1/4" MAX HEIGHT SASH LOCK ALLOWANCE EXTERIOR LOW E 189 11/11/2015 - 24"X20" UNIT DIMENSIONS 26-1/2"W. X 51"H. 25%" O.A.S.W. SCALE: - D.P. RATING GLAZING - 20"X24" UNIT DIMENSIONS 22-1/2"W. X 59"H NOTED - HISTORIC 1-3/4" THICK WESTERN RED CEDAR SILLS DWG, NO: - 5/4"X4" OR 4/4"X5' NOMINAL WESTERN RED CEDAR CASING SK2B5.0 - WHITE ROLLED FORM ALUMINUM FULL SCREEN FRAMES · CHARCOAL FIBERGLASS SCREEN \mathbf{OF} 34" S.L. PLOT DATE: 11/11/2015

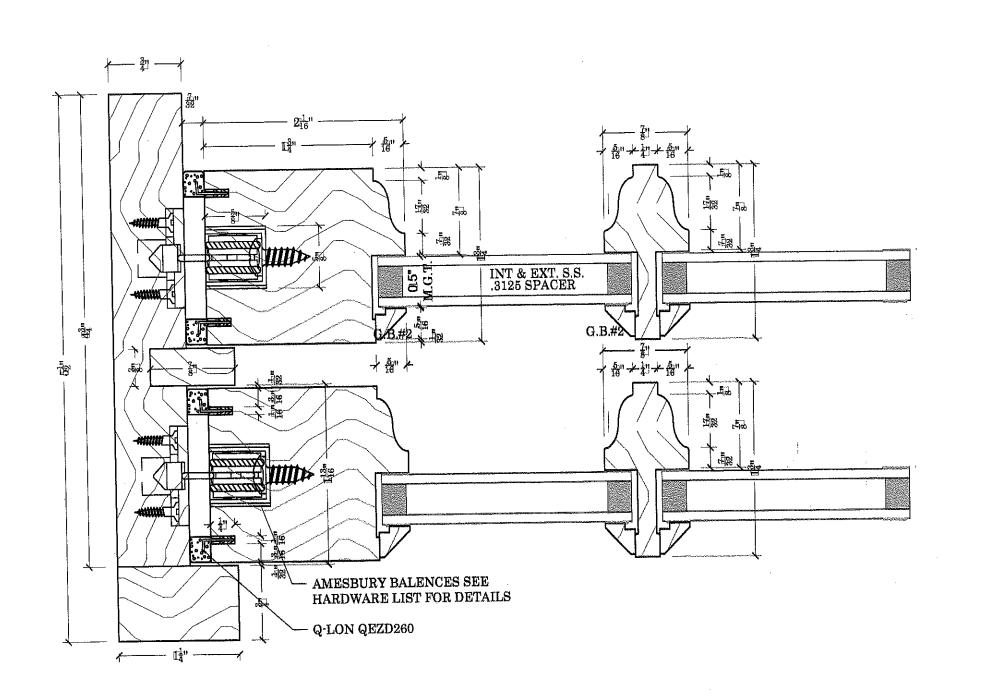



SASH & WILLWORK 667 SPRING STREET NORTH DIGHTON, MA.52764 PHONE # (508) 880-8808 FAX # (508)880-8828 WWW.BOSTONSASH.COM

B.S.& M. STANDARDS CONCEALED BALANCE OPTION 5

P.O.#

BEACON HILL PROFILE

PLAN DETAIL

B.S.S.

N/A CONTRACTOR

N/A

ARCHITECT N/A

PROJECT MANAGER

N/A DRAWN BY:

KEITH KUTHAN

DATE: 11/11/2015

SCALE


F.S.

SK2B5.1

2 OF <u>6</u>

PLOT DATE:

FILE LOCATION

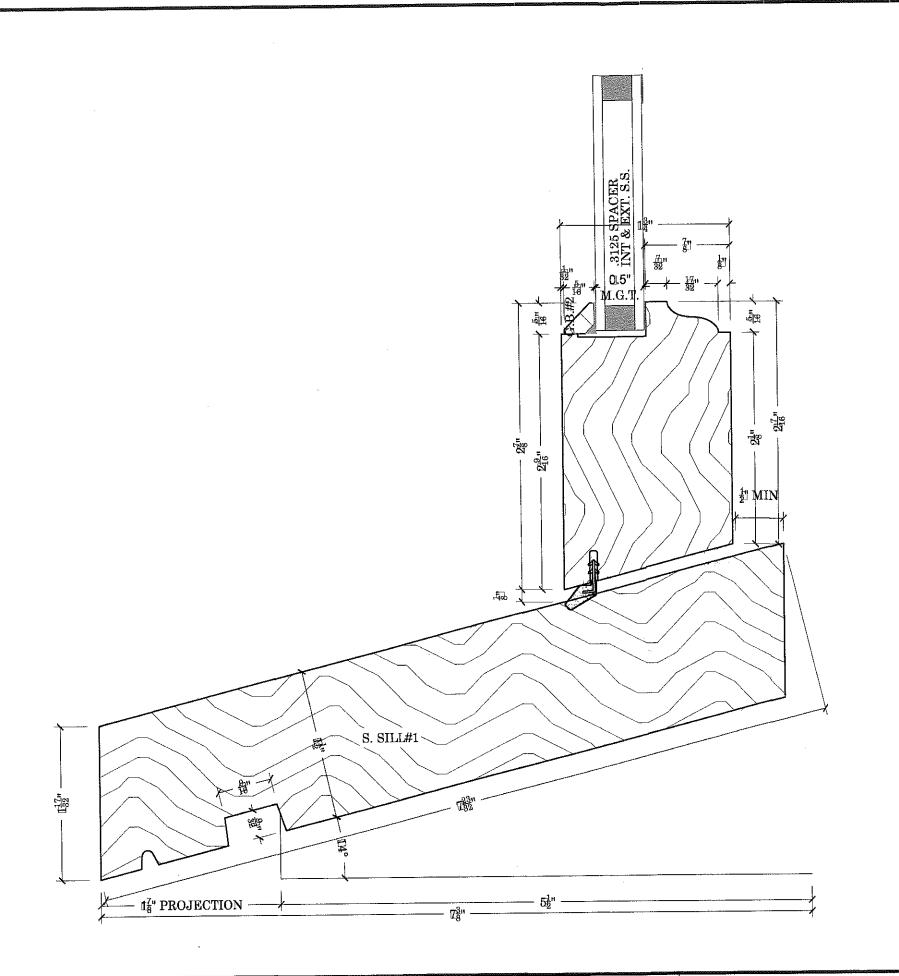



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 \mathcal{T} CONCEALED BALANCE OPTION B.S.& M. STANDARDS

P.O,# B.S.S.

PITON: STANDARD 1-1/2" SILL DETAIL

BEACON HILL PROFILE

DEALER N/A

CONTRACTOR

N/A ARCHITECT

N/A

PROJECT MANAGER N/A

DRAWN BY: KEITH KUTHAN

> DATE: 9/23/16


SCALE: F.S.


DWG. NO:

SK2B5.4

SHEET: 5_ \mathbf{OF} 6

PLOT DATE: 11/11/2015 FILE LOCATION:

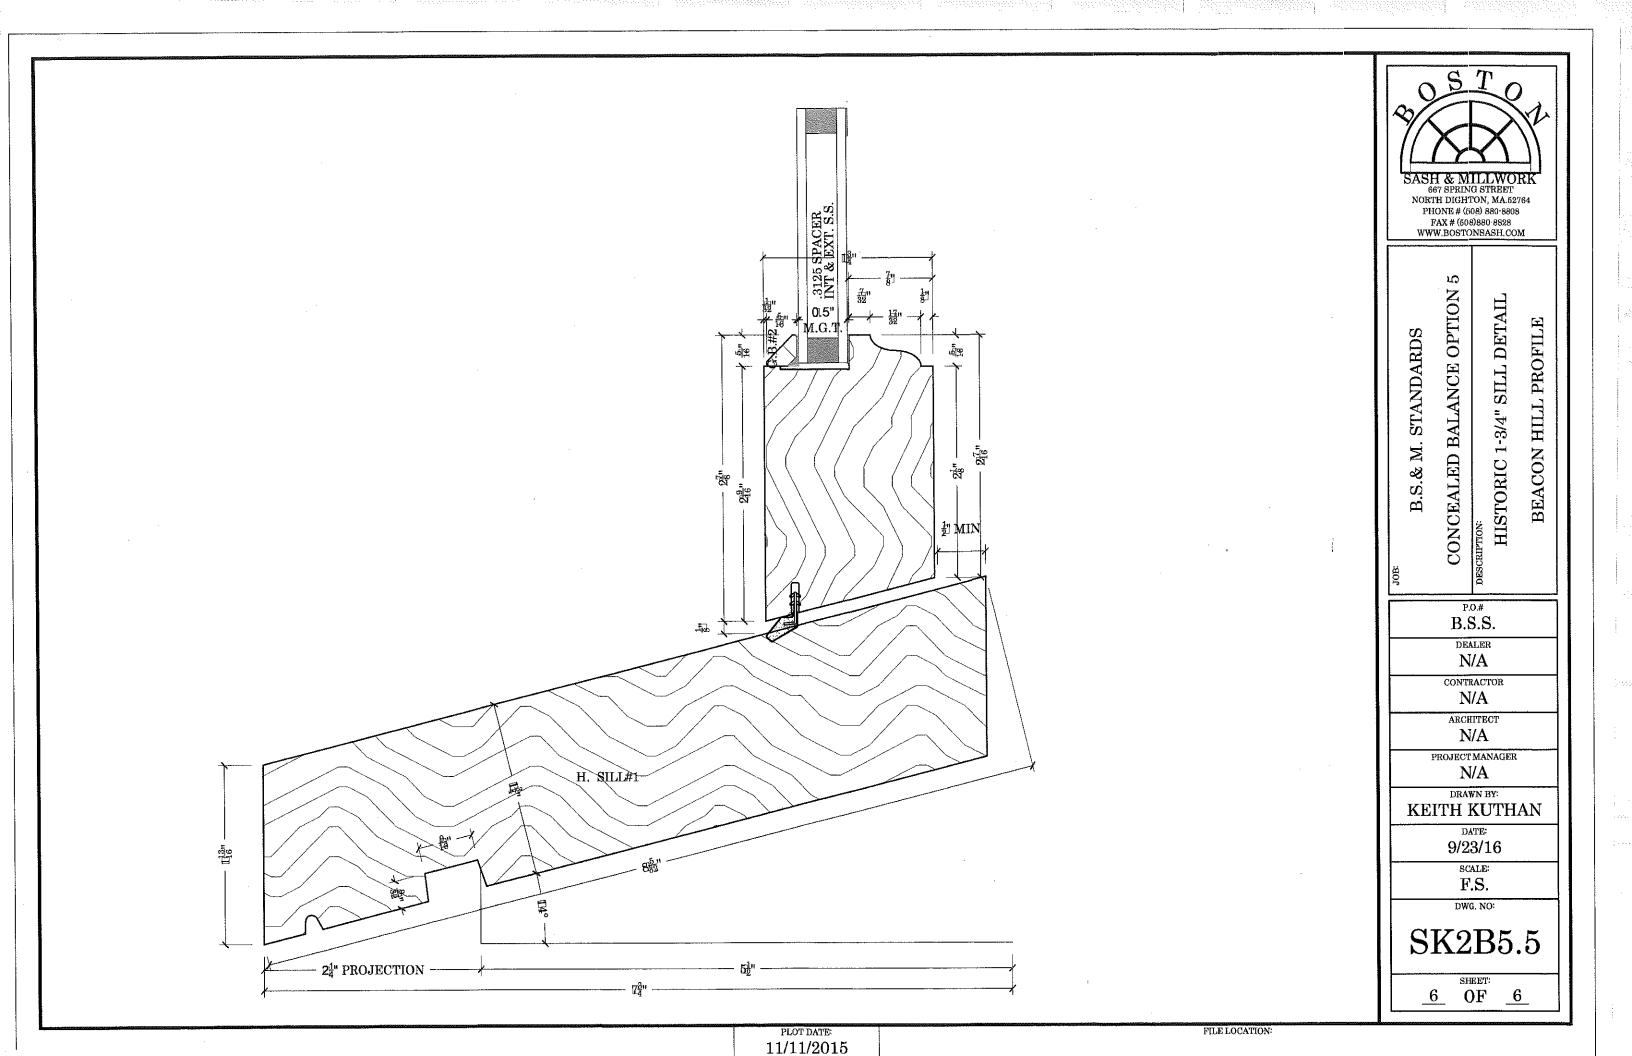

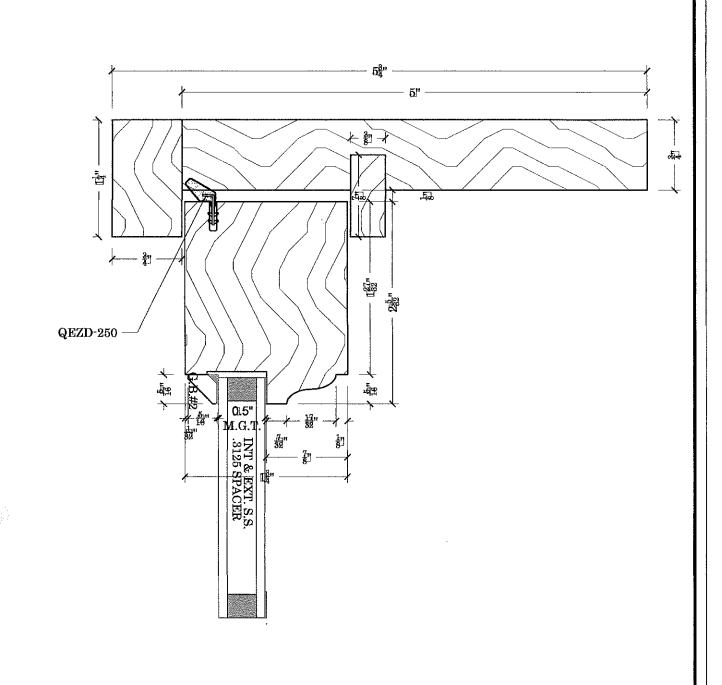



SASH & MILLWORK 667 SPRING STREET NORTH DIGHTION, MA.22764 PHONE # (508) 880-8808 FAX # (508) 880-8828 WWW.BOSTONSASH.COM B.S.& M. STANDARDS


CONCEALED BALANCE OPTION 5

DESCRIPTION:

JOB:

HEAD DETAIL
BEACON HILL PROFILE

DRAWN BY:	
KEITH KUTHAN	
JOB NO:	DWG. NO:
B.S.S.	SK2B5.2
DATE: 9/23/16	
scale: F.S.	3 OF 6

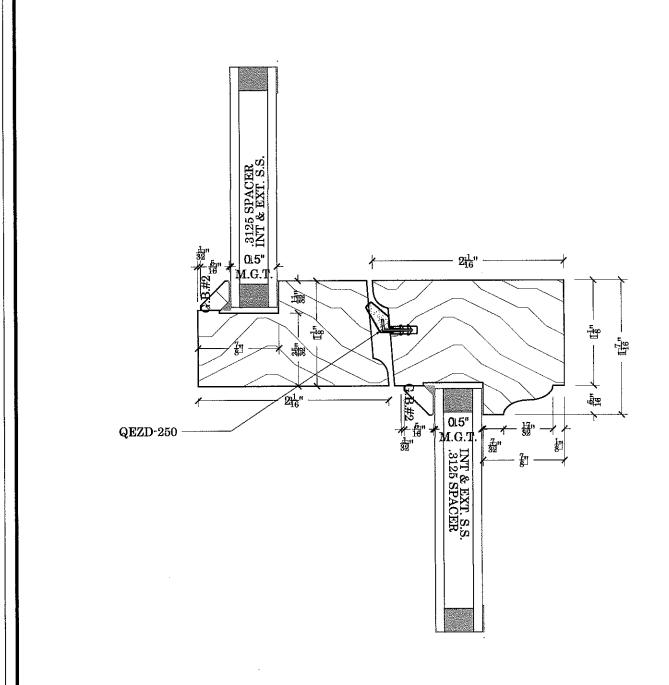



SASH & MILLWORK
667 SPRING STREET
NORTH DIGHTON, MA.32764
PHONE # (508) 880-8808
FAX # (508)880-8828
WWW.BOSTONSASH.COM

JOB:

B.S.& M. STANDARDS
CONCEALED BALANCE OPTION 5

DESCRIPTION:

CHECK RAIL DETAIL
BEACON HILL PROFILE

DRAWN BY:	
KEITH KUTHAN	
JOB NO:	DWG. NO:
B.S.S.	SK2B5.3
DATE: 2/21/17	
scale: F.S.	SHEET: _4 OF _6_